

TBM NO.	DESCRIPTION	ELEV.
1	DOWNHILL BOLT OF CHAIRLIFT BASE	1010.91'
2	TOP BOLT OF ELEC. PULL BOX COVER	997.97'
3	TOP BOLT OF ELEC. PULL BOX COVER	997.83'
4	TOP S.E. CORNER OF TRANS. PAD	999.59'
5	TOP S.W. CORNER OF TRANS. PAD	999.42'
6	P-K In PINE TREE	999.10'
7	P-K In PINE TREE	997.84'

All Disturbed Areas To Be Revegetated As Follows:


Hay Mulch 2 Bales/1000 sq. ft.
 Ground Limestone 138 lb./1000 sq. ft.
 Fertilizer 10-20-20 18.4 lb./1000 sq. ft.

SEED MIX

Crawling Red Fescue 0.46 lb./1000 sq. ft.
 Red Top 0.05 lb./1000 sq. ft.
 Tall Fescue 0.46 lb./1000 sq. ft.

EMBANKMENT SEEDING MIXTURE

Species	Varieties	Lb. Per Acre
Flatpea	Lathco	10.0
Perennial Pea	Lancer	2.0
Crownvetch	Penngift, Chemug	10.0
Tall Fescue	Ky-31, Rebel, Ken-Hi	10.0

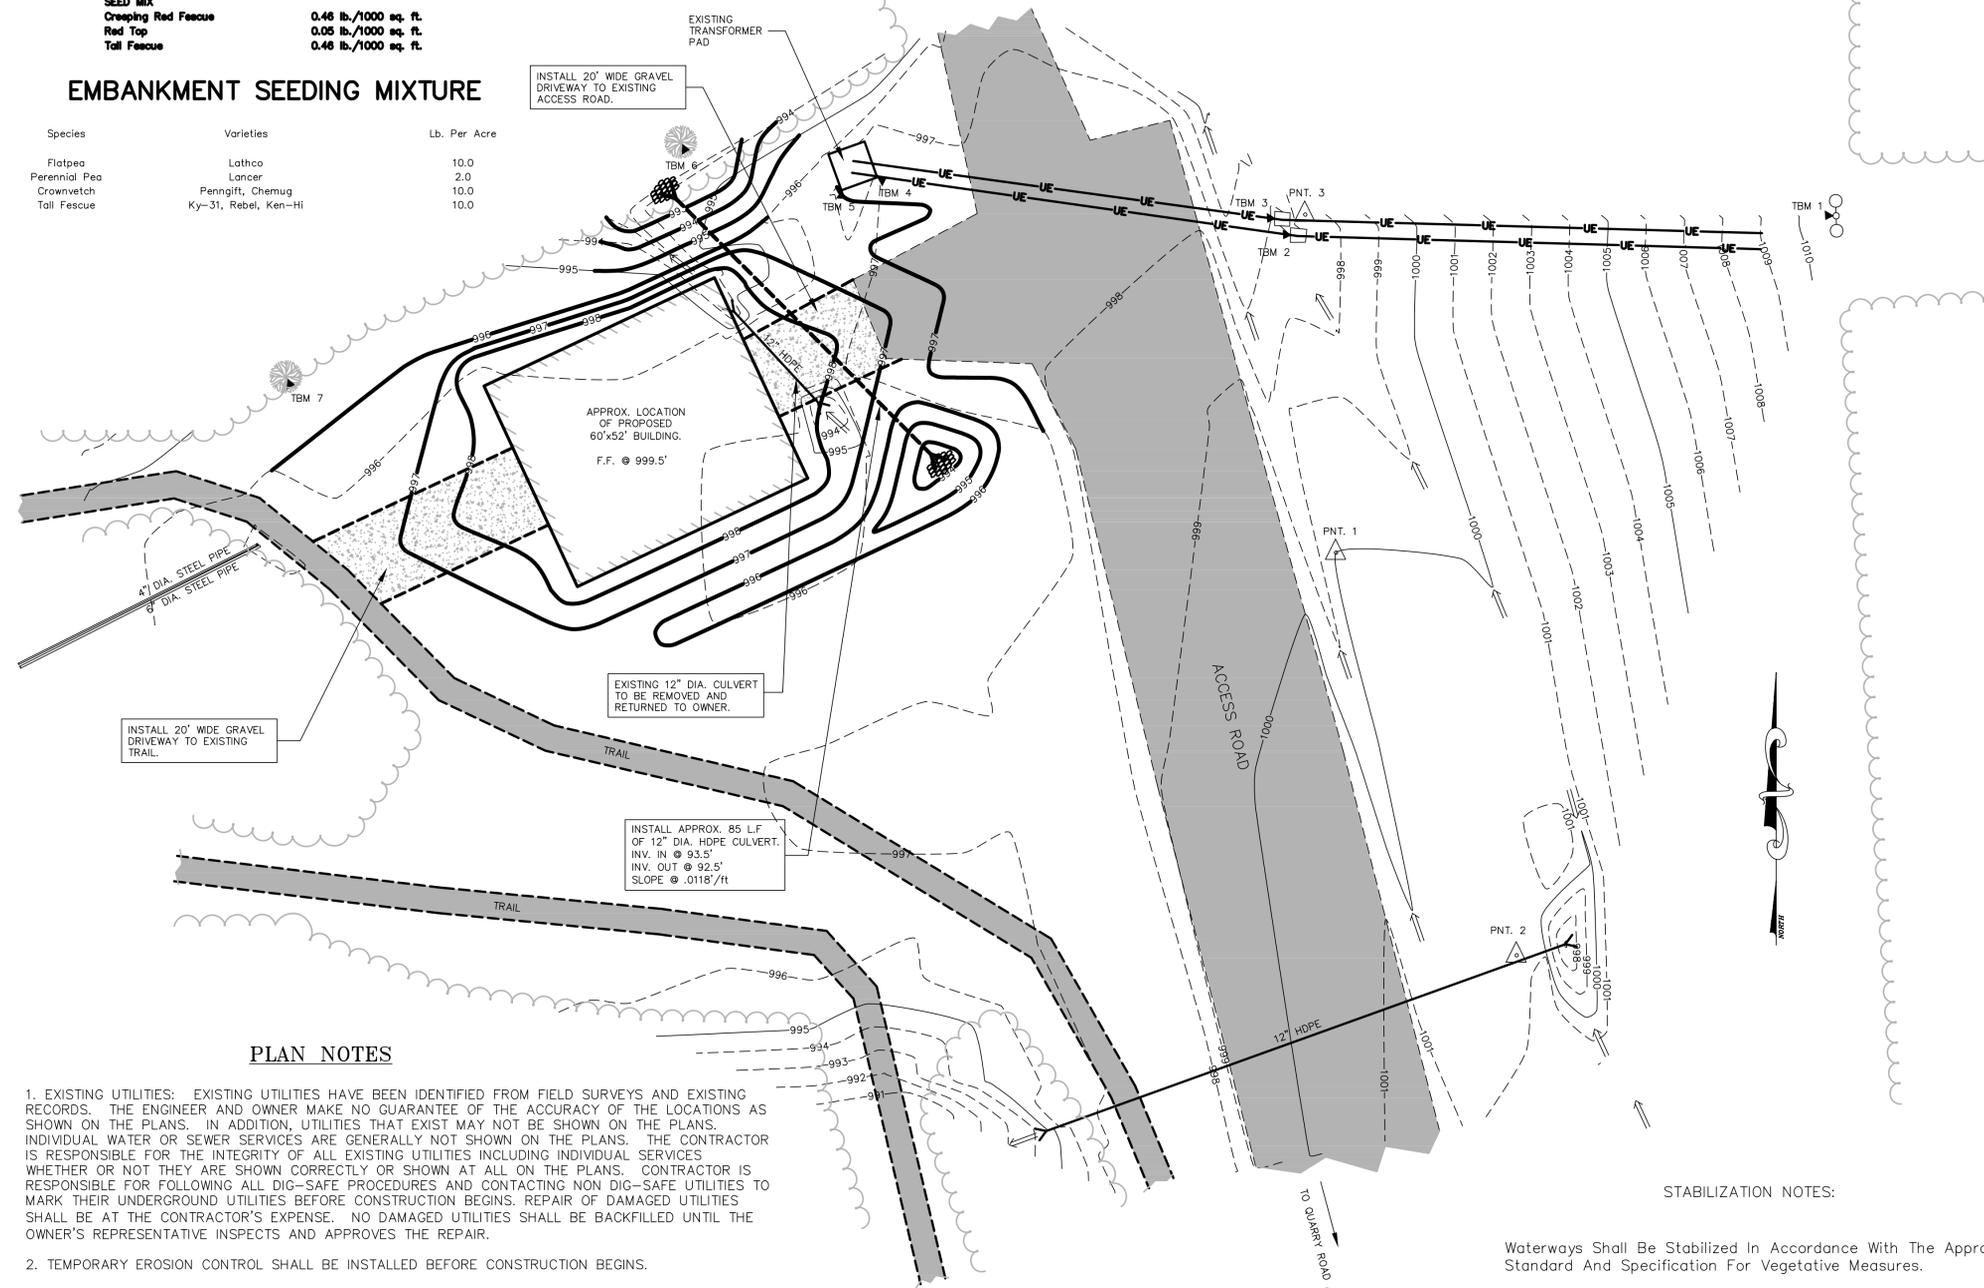

PLAN NOTES

- EXISTING UTILITIES: EXISTING UTILITIES HAVE BEEN IDENTIFIED FROM FIELD SURVEYS AND EXISTING RECORDS. THE ENGINEER AND OWNER MAKE NO GUARANTEE OF THE ACCURACY OF THE LOCATIONS AS SHOWN ON THE PLANS. IN ADDITION, UTILITIES THAT EXIST MAY NOT BE SHOWN ON THE PLANS. INDIVIDUAL WATER OR SEWER SERVICES ARE GENERALLY NOT SHOWN ON THE PLANS. THE CONTRACTOR IS RESPONSIBLE FOR THE INTEGRITY OF ALL EXISTING UTILITIES INCLUDING INDIVIDUAL SERVICES WHETHER OR NOT THEY ARE SHOWN CORRECTLY OR SHOWN AT ALL ON THE PLANS. CONTRACTOR IS RESPONSIBLE FOR FOLLOWING ALL DIG-SAFE PROCEDURES AND CONTACTING NON DIG-SAFE UTILITIES TO MARK THEIR UNDERGROUND UTILITIES BEFORE CONSTRUCTION BEGINS. REPAIR OF DAMAGED UTILITIES SHALL BE AT THE CONTRACTOR'S EXPENSE. NO DAMAGED UTILITIES SHALL BE BACKFILLED UNTIL THE OWNER'S REPRESENTATIVE INSPECTS AND APPROVES THE REPAIR.
- TEMPORARY EROSION CONTROL SHALL BE INSTALLED BEFORE CONSTRUCTION BEGINS.
- TEST PITS SHALL BE COMPLETED BEFORE CONSTRUCTION BEGINS.
- NO TRENCH SHALL BE LEFT OPEN OVERNIGHT. IF TRENCH IS NOT BACKFILLED, SECURE WITH CONCRETE BARRIERS AND STEEL PLATE OVER TRENCH.
- CONTRACTOR SHALL COORDINATE WITH ELECTRICAL UTILITY FOR HOLDING UTILITY POLES AS NEEDED. COST FOR THIS WORK WILL BE PAID BY THE CONTRACTOR.
- CONTRACTOR SHALL KEEP DAILY FIELD NOTES AND ACCURATE SWING TIES TO ALL EXISTING AND NEW UTILITIES INCLUDING APPARENTLY ABANDONED UTILITIES. THIS INFORMATION SHALL BE FURNISHED TO THE OWNER/ENGINEER ON A WEEKLY BASIS AND PRIOR TO PROJECT COMPLETION.
- WATER/SEWER SERVICE SHALL BE MAINTAINED TO CUSTOMERS AT ALL TIMES. NO ADDITIONAL CHARGES WILL BE PAID FOR TEMPORARY SERVICES NEEDED.
- THE CONTRACTOR SHALL USE TRENCH BOXES AND FOLLOW OSHA SAFETY REQUIREMENTS AT ALL TIMES WHILE COMPLETING CONSTRUCTION WORK.
- TRAFFIC CONTROL SHALL BE IN ACCORDANCE WITH MUTCD RECOMMENDATIONS, LATEST REVISION AND STATE AND LOCAL LAWS.
- LOAM MUST BE ROLLED AND OF UNIFORM GRADE BEFORE SEEDING AND MULCHING.
- ALL STORM DRAIN PIPE SHALL BE PERFORATED AT THE 5 O'CLOCK AND 7 O'CLOCK POSITIONS AND INSTALLED HOLES DOWN UNLESS OTHERWISE NOTED.
- ALL PAVEMENT SHALL BE CUT UNIFORMLY PRIOR TO EXCAVATION.



LEGEND:

△	ANGLE POINT	□	BUILDING
○	UTILITY POLE	—	CULVERT
☆	HYDRANT	—	ASPHALT ROAD
⊙	MANHOLE	—	GRAVEL ROAD
⊕	TREE	—	EXIST. WATER
⊗	GAS VALVE	—	EXIST. SEWER
▽	TBM	—	UNDERGROUND TEL.
■	CATCH BASIN	—	UNDERGROUND ELEC.
⊠	TEST PIT	—	STORM DRAIN
⊙	TEST BORING	—	FENCE
---	EXIST. CONTOUR	---	PROPOSED CONTOUR

STABILIZATION NOTES:

Waterways Shall Be Stabilized In Accordance With The Appropriate Standard And Specification For Vegetative Measures.

- All Trees, Brush, Stumps, Obstructions And Other Objectionable Material Shall Be Removed And Disposed Of So As Not To Interfere With The Proper Functioning Of The Waterway.
- The Waterway Shall Be Excavated Or Shaped To Line, Grade, And Cross Section As Required To Meet The Criteria Specified Herein, And Be Free Of Bank Projections Or Other Irregularities Which Will Impede Normal Flow.
- Fills Shall Be Compacted As Needed To Prevent Unequal Settlement That Would Cause Damage In The Completed Waterway.
- All Earth removed and Not Needed In Construction Shall Be Spread Or Disposed Of So That It Will Not Interfere With The Functioning Of The Waterway.
- Construction Operations Shall Be Carried Out In Such A Manner That Erosion And Air and Water Pollution Will Be Minimized. State and Local Laws Will Be Complied With.
- Stabilization Shall Be Done According To The Appropriate Standard And Specifications For Vegetative Practices.

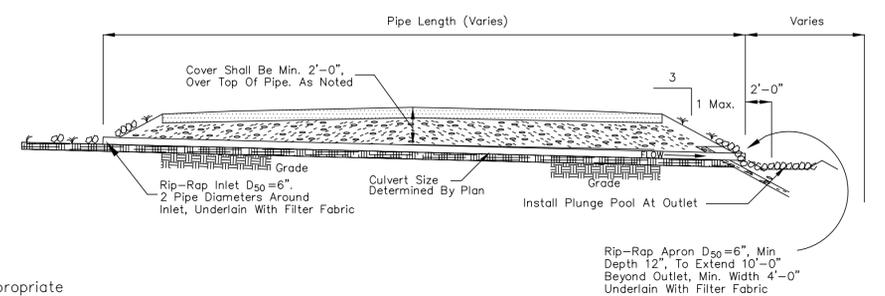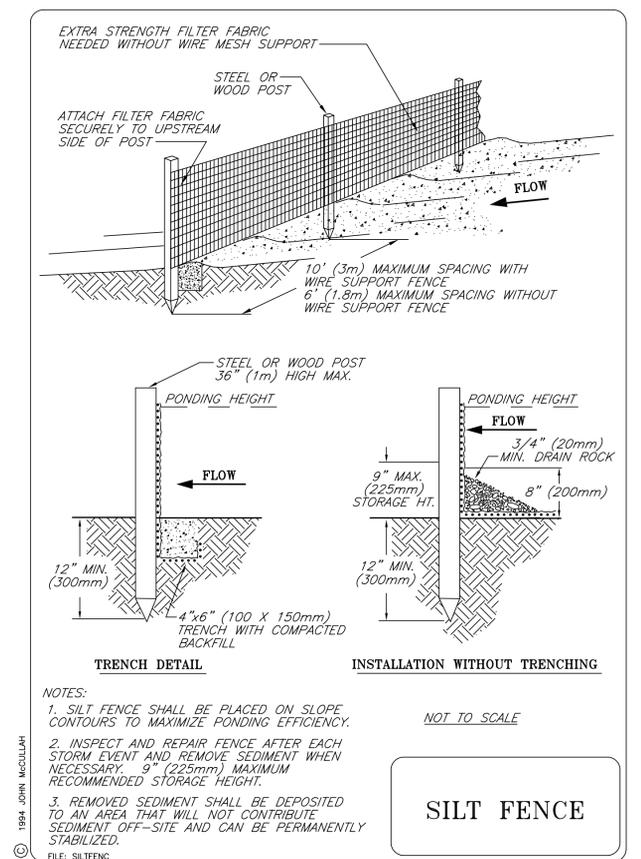

Typical Culvert Cross-Section

No.	Revisions	Date	App'd.
PUMP HOUSE BUILDING			
QUARRY ROAD		WATERVILLE, MAINE	
SITE PLAN			
PRELIMINARY	AEHodsdon CONSULTING ENGINEERS		Sheet No.
	10 Common St., Waterville, Me. 04901 (207) 873-5164		1
	Drawn By: BB	Scale: 1" = 20'-0"	
	Checked By:	Date:	
	Approved By:	Date:	
File No. 43-12.DWG	Project No. 43-12	of	1